





google.com/maps SITE LOCATION

# PROPOSED NEW DWELLING + DETACHED SHED

(+ SWIMING POOL)

#### SCHEDULE OF DRAWINGS

SHEET NAME	SHEET NUMBER	<b>Current Revision</b>
SITE INFORMATION	A000	5
SITE PLAN	A001	5
SITE AREAS	A002	5
ROOF PLAN	A003	5
FLOOR PLAN	A004	5
SCHEDULES	A005	5
ELEVATIONS	A006	5
ELEVATIONS	A007	5
SECTIONS	A008	5
SHED PLAN	A009	5
ELEVATIONS	A010	5
SEDIMENT EROSION CONTROL	A011	5
SEDIMENT EROSION CONTROL	A012	5



SITE DETAILS

SITE AREA: 2007 sqm

**R2 LOW DENSITY RESIDENTIAL** 

DETACHED SHED + POOL

DEVELOPMENT TYPE:

TAMWORTH REGIONAL COUNCIL PROPOSED NEW DWELLING +

LOCAL GOVERNMENT AREA:

**BUILDING CLASSIFICATION:** CLASS 1A + 10A

WIND CLASSIFICATION:

N2 SITE CLASSIFICATION TO AS 4055-2021

SOIL CLASSIFICATION:

REFER TO ENG. DETAILS

CLIMATE ZONE:

4 (WWW.ABCB.GOV.AU MAP)

**BUSHFIRE PRONE LAND:** 

N/A NO AREAS OF BUSHFIRE

OTHER CONTROLS:



#### **PROPOSED NEW DWELLING + SHED**

37 GLENMORE DRIVE, MOORE CREEK



SCALE

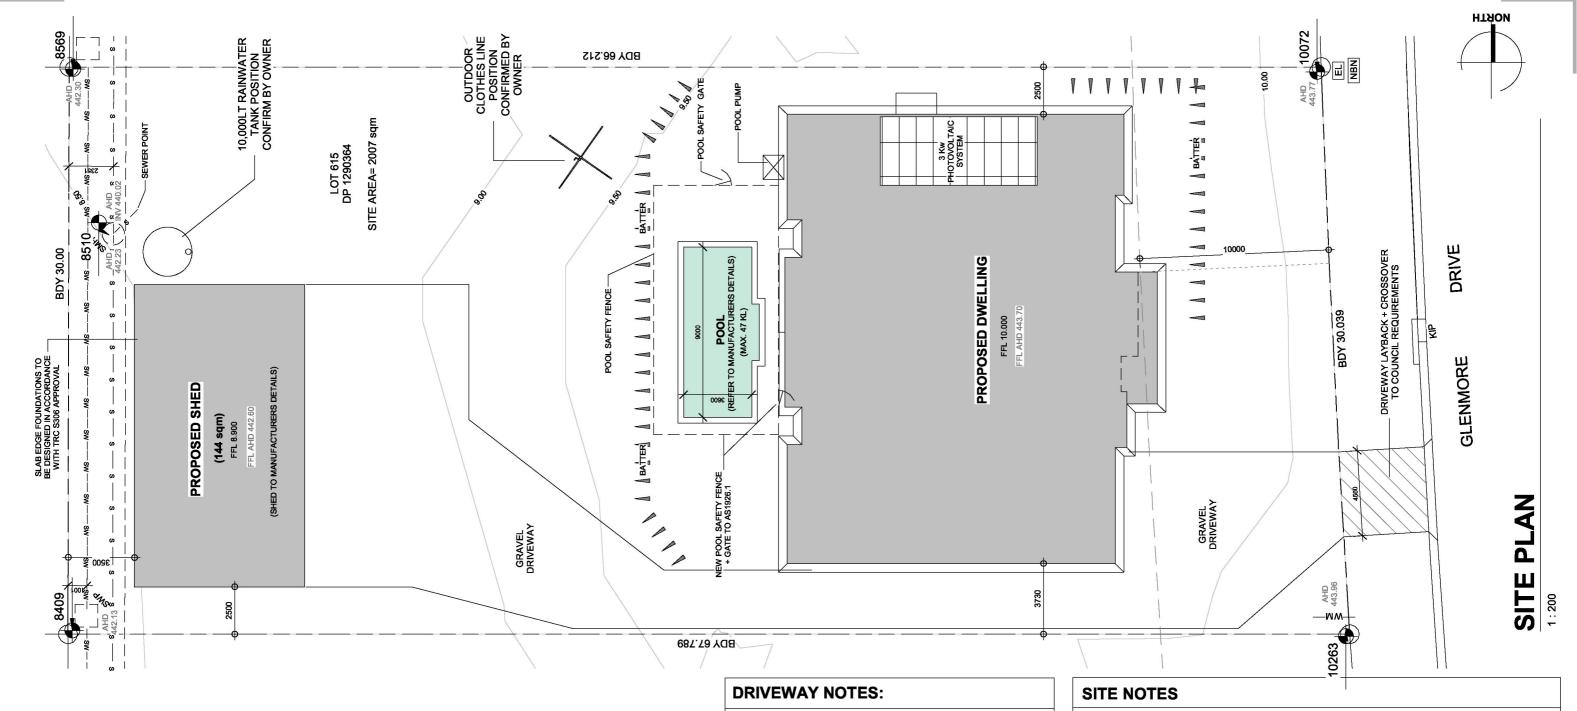
DESCRIPTION PRELIMINARY ISSUE REVISED FLOOR PLAN FOR DA SUBMISSION

DATE 17/09/2024 21/11/2024 17/12/2024 04/02/2025

A000

PROJECT No.

1186-24



#### **LEGEND** TELSTRA PIT AUST HEIGHT DATUM LEVEL AHD 400 FLECTRICAL PIT F -sw-sw- STORMWATER DRAINAGE WM WATER METER —s—s— SEWER PP POWER POLE d DOWNPIPE — w — w — WATER SWP STORMWATER PIT -T- TELSTRA SMH SEWER ACCESS CHAMBER -OPT----OPT--- OPTIC FIBRE KIP KERB INLET PIT -E- ELECTRICAL **HYDRANT** LB LETTER BOX -OHP-- OVERHEAD POWER LP LIGHT POLE -gs- GAS LINE GAS **GAS PIT** -EXSW-EXSW- EXISTING STORMWATER -10000-APPROX. SURFACE CONTOUR —EXS—EXS— EXISTING SEWER **DESIGN SURFACE LEVEL**

DRIVEWAY CONSTRUCTION TO COMPLY WITH TRC ENGINEERING DESIGN GUIDLINES FOR SUBDIVISIONS & DEVELOPMENTS- 2.7.3 PART 2 TABLE F

DRIVEWAY + LAYBACK TO BE INSTALLED TO TRC ENGINEERING DESIGN GUIDLINES FOR SUBDIVISIONS & DEVELOPMENTSDRAWINGS 844-3.04B + 8281

DRIVEWAY SHALL BE INSTALLED WITH SATISFACTORY CLEARANCE TO ANY UTILITY POLE, STORMWATER + SEWER PITS OR MANHOLES OR ANY STREET TREE. ANY ALTERATION OR RELOCATION TO THE ABOVE SHALL REQUIRE APPROVAL FROM RELEVANT AUTHORITY

DRIVEWAY ACCESS TO CROSS FOOTPATHS PERPENDICULAR TO ACCESS ROAD

DRIVEWAY CONSTRUCTION SHALL ENABLE ACCESS FOR ALL TYPES OF DOMESTIC + SMALL COMMERCIAL VEHICLES

DRIVEWAY CONSTRUCTION SHALL HAVE A NON-SLIP SURFACE FINISH

LAYBACK SHALL BE CONSTRUCTED WITH THE BACK OF THE LAYBACK LEVEL WITH THE HEIGHT OF THE KERB + GUTTER

ALL SURFACE WATER TO FALL AWAY FROM BUILDING IN ALL DIRECTIONS IN ACCORDANCE WITH REQUIREMENTS OF AS2870 + NCC HP PART 3.3.3

DOWNPIPES TO BE CONNECTED INTO STORMWATER AS SOON AS THE ROOF IS INSTALLED.

DOWNPIPES SHOULD BE AT A MAXIMUM OF 12 METER CENTRES + AS CLOSE TO VALLEYS AS POSSIBLE AND IN ACCORDACE WITH NCC HP PART 7.4 + NCC VOL. 3

EXCAVATED MATERIAL STORED ON SITE SHALL BE PLACED UP-SLOPE OF SEDIMENT FENCE. INSTALL A SEDIMENT FENCE ON THE DOWNSLOPE SIDE OF MATERIAL.

CONSTRUCTION VEHICLES TO BE PARKED ON THE STREET, TO PREVENT TRANSFERRING DEBRIS ONTO STREET. UNLESS ALTERNATIVE SEDIMENT TRANSFER REDUCTION METHODS ARE IN PLACE

ALL EXISTING UNDERGROUND SERVICES MUST BE LOCATED AND EXPOSED PRIOR TO EARTHWORKS COMMENCING & IT IS THE RESPONSIBILITY OF THOSE PERSONS USING THIS PLAN TO CONFIRM BOTH POSITION & LEVEL OF THESE UTILITIES IN CONJUNCTION WITH THE APPROPRIATE AUTHORITY.



#### **PROPOSED NEW DWELLING + SHED**

37 GLENMORE DRIVE, MOORE CREEK

SCALE As indicated

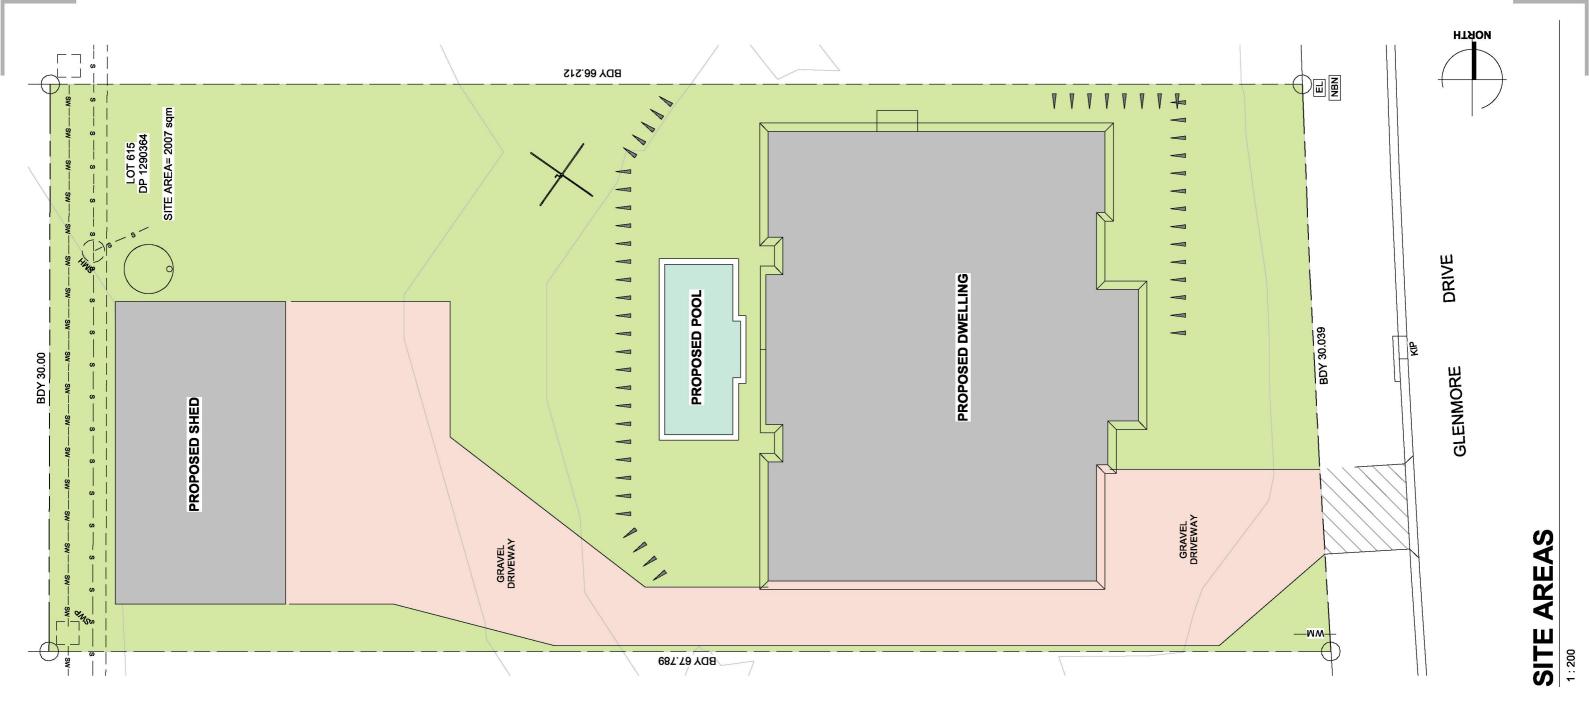
DATE 08/04/2025

DRAWN SAE

DESIGNED SAE

REVISION DESCRIPTION
PRELIMINARY ISSUE
REVISED FLOOR PLAN
FOR DA SUBMISSION
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DATE 17/09/2024 21/11/2024 17/12/2024 04/02/2025 08/04/2025 PROJECT No. 1186-24





INTERNAL DRIVEWAYS (GRAVEL) 420 sqm



DRIVEWAY CROSSOVER 20 sqm



**PROPOSED NEW DWELLING + SHED** 

37 GLENMORE DRIVE, MOORE CREEK

**SCALE** 1:200 08/04/2025 DRAWN SAE

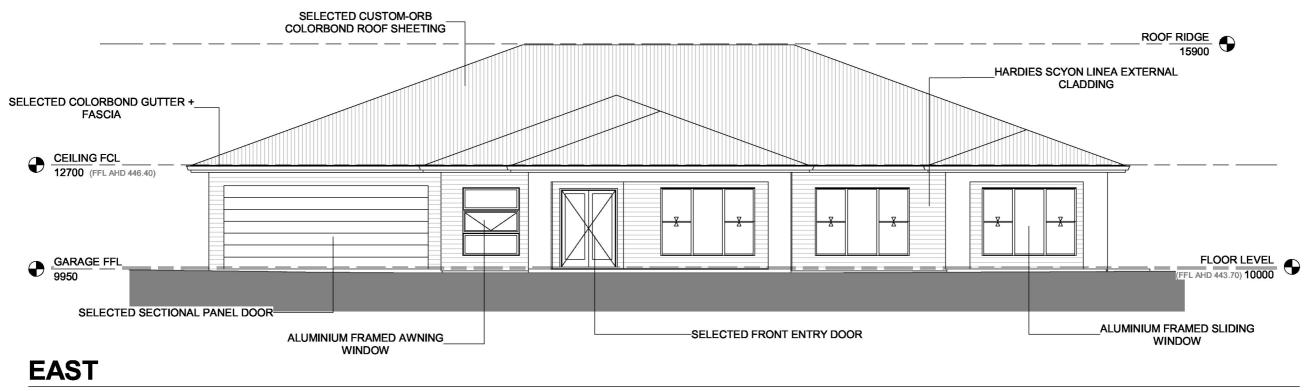
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DATE

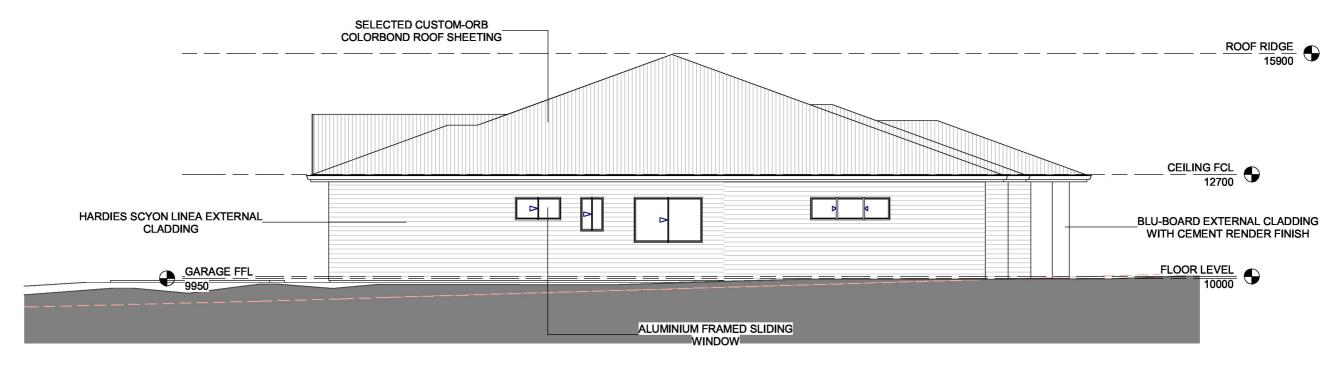
DESIGNED

DESCRIPTION PRELIMINARY ISSUE REVISED FLOOR PLAN REVISED FLOOR PLAN FOR DA SUBMISSION DATE 17/09/2024 21/11/2024 17/12/2024 04/02/2025 08/04/2025

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1:100



### **SOUTH**

1:100



## PROPOSED NEW DWELLING + SHED

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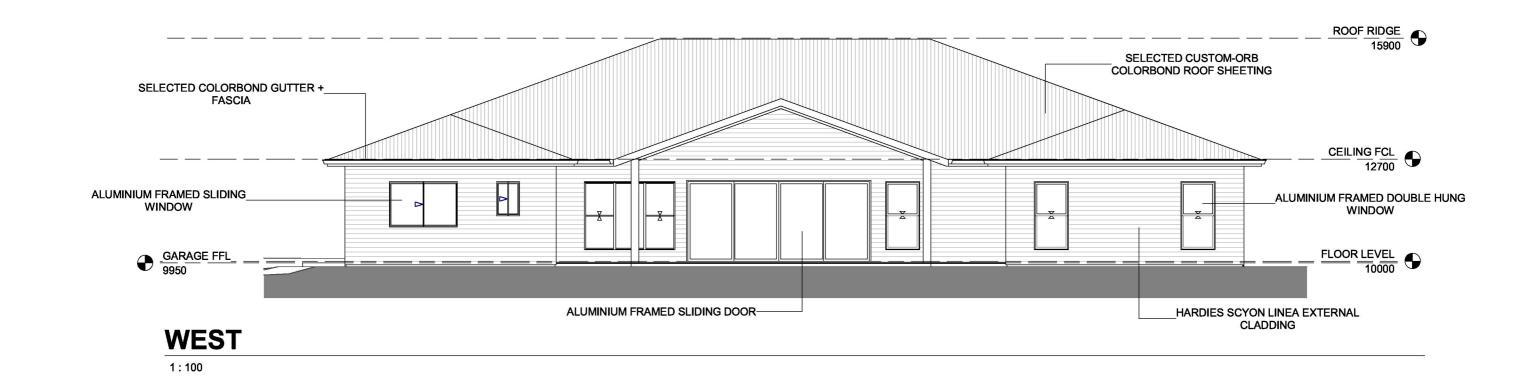
SCALE	1:100	REVISION 1 2	DESCRIPTION PRELIMINARY ISSUE REVISED FLOOR PLAN	DATE 17/09/2024 21/11/2024
DATE	08/04/2025	3 4	REVISED FLOOR PLAN FOR DA SUBMISSION	17/12/2024 04/02/2025
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#### **NORTH**

1:100



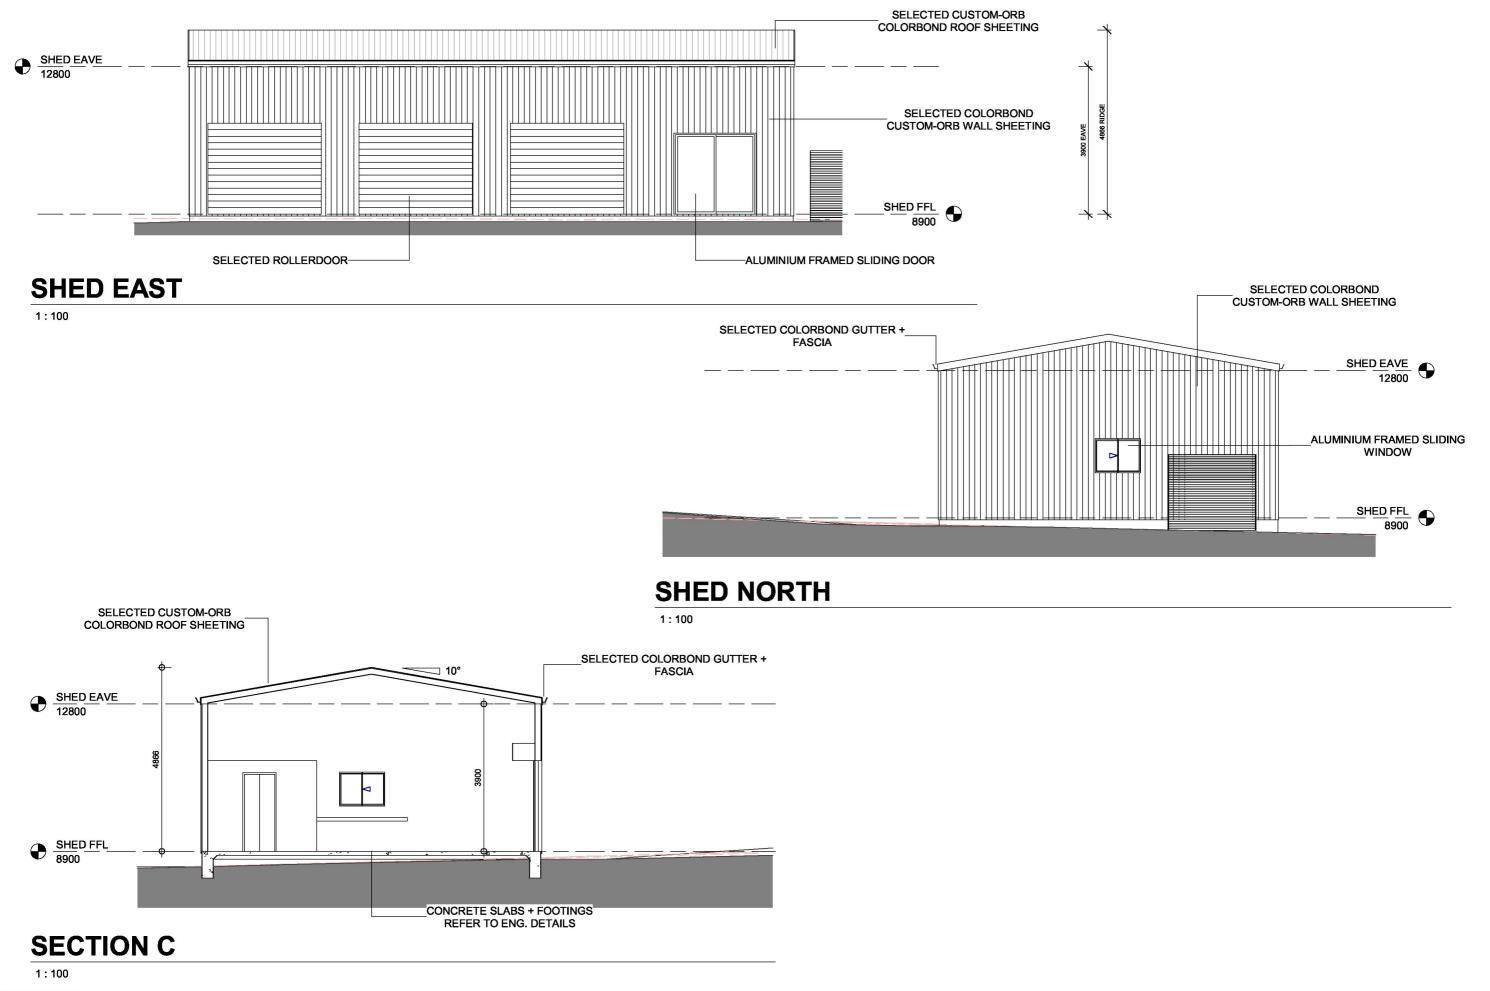


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37 GLENMORE DRIVE, MOORE CREEK

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		5	FOR DA SUBMISSION	08/04/2025
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PROJECT No. 1186-24



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